
# THE CHAPEL AT

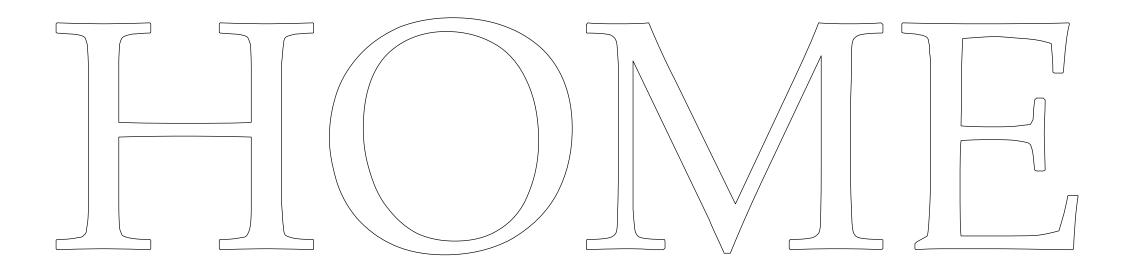

# COPYRIGHT SWILLEY DESIGN 2021

# GENERAL REQUIREMENTS AND CONDITIONS:

- I. THIS DESIGN FIRM AND IT'S PRINCIPALS ASSUME NO RESPONSIBILITY FOR ANY HOME CONSTRUCTED FROM THESE PLANS.
- 2. ALL WORK SHALL CONFORM TO CURRENT EDITIONS OF NATIONAL, STATE AND LOCAL CODES AND ANY OTHER REGULATING AGENCIES WHICH HAVE AUTHORITY OVER WORK PERFORMED, ALL CONTRACTORS AND SUBCONTRACTORS PERFORMING GENERAL CONSTRUCTION, MECHANICAL, ELECTRICAL, PLUMBING OR RELATED WORK SHALL COMPLY WITH APPLICABLE SECTIONS OR GOVERNING CODES.
- 3. THESE PLANS HAVE BEEN PREPARED WITH THE INTENT TO COMPLY WITH ALL APPLICABLE STATE, COUNTY, CITY AND SPECIFIC DEVELOPMENT CODES, LAWS, BY-LAWS, COVENANTS AND RESTRICTIONS. CONTRACTOR SHALL CAREFULLY STUDY AND COMPARE THE PLANS AND DOCUMENTS PRIOR TO ANY CONSTRUCTION OR MATERIAL ORDER AND SHALL REPORT ANY ERRORS INCONSISTENCIES OR OMISSIONS TO DESIGNER FOR CORRECTION. ALL CONSTRUCTION BY THE GENERAL CONTRACTOR, HIS SUBCONTRACTORS, YENDORS, MATERIALS, EQUIPMENT AND SYSTEMS
- INCORPORATED INTO THE CONSTRUCTION, EITHER DRAWN OR IMPLIED IN THESE DRAWINGS, SHALL MEET APPLICABLE CITY, COUNTY AND STATE REQUIREMENTS, NOTHING IN THE DRAWINGS OR SPECIFICATIONS IS TO BE CONSTRUED AS REQUIRING OR PERMITTING WORK THAT IS CONTRARY TO THESE RULES, REGULATIONS, CODES OR ORDINANCES.
- 4. CONTRACTOR 6HALL BE RESPONSIBLE FOR OBTAINING THE BUILDING PERMIT, ALL OTHER REQUIRED PERMITS, GOVERNMENTAL FEES, LICENSES AND INSPECTIONS NECESSARY FOR THE PROPER EXECUTION AND COMPLETION OF WORK, THE GENERAL CONTRACTOR SHALL COORDINATE REQUIREMENTS FOR CONSTRUCTION WITH AUTHORITIES HAVING JURISDICTION, NO WORK SHALL BE DONE WITHOUT THE PROPER PERMITS.
- 5. CERTAIN DESIGN ASSUMPTIONS ARE MADE IN THESE PLANS IN REGARD TO MATERIAL CHOICES, CONSTRUCTION METHODS, STRUCTURAL DESIGN, FOUNDATION DESIGN, WALL THICKNESSES AND FLOOR SYSTEM DEPTHS AND CONFIGURATIONS. STRUCTURAL, MECHANICAL, ELECTRICAL AND PLUMBING DRAWINGS, IF ANY, SUPPLEMENT THESE DRAWINGS, SHOULD THERE BE ANY DISCREPANCY BETWEEN THESE DRAWINGS AND THE OTHER SUPPLEMENTAL DRAWINGS, CONTRACTOR SHALL BRING IT TO THE ATTENTION OF THE DESIGNER PRIOR TO ANY WORK OR MATERIAL PURCHASE FOR CORRECTION, THE CONTRACTOR IS RESPONSIBLE FOR VERIFICATION THAT ALL SUPPLEMENTAL DRAWINGS, IF ANY, ARE COMPATIBLE WITH EACH OTHER, ARE OF SOUND DESIGN, AND SHALL MEET NATIONAL, STATE AND LOCAL BUILDING CODES.
- 6. THIS DESIGN FIRM AND ITS PRINCIPALS WILL NOT BE RESPONSIBLE FOR AND WILL NOT HAVE CONTROL OR CHARGE OF CONSTRUCTION MEANS, METHODS, TECHNIQUES, SEQUENCES OF PROCEDURES OR CHOICE OF MATERIALS IN CONNECTION WITH THIS PROJECT AND WILL NOT BE RESPONSIBLE FOR CONTRACTOR'S FAILURE TO CARRY OUT THE WORK ON THIS PROJECT IN ACCORDANCE WITH THESE DOCUMENTS OR APPLICABLE BUILDING CODES AND ORDINANCES, IN ADDITION, THIS DESIGN FIRM AND ITS PRINCIPALS WILL NOT BE RESPONSIBLE FOR OR HAVE CONTROL OR CHARGE OVER THE ACTS OR OMISSIONS OF THE CONTRACTOR, SUBCONTRACTORS OR ANY OF THEIR AGENTS OR EMPLOYEES OR ANY OTHER PERSON PERFORMING WORK ON THIS PROJECT, NO SITE INSPECTIONS WILL BE CONDUCTED BY DESIGNER FOR THIS PROJECT,
- 7. ALL ENVIRONMENTAL ISSUES AND BUILDING SITE CONDITIONS ARE THE SOLE RESPONSIBILITY OF THE BUILDER AND OWNER. THIS DESIGN FIRM AND ITS PRINCIPALS SHALL NOT BE RESPONSIBLE FOR DISCOVERY OR TESTING IN REGARD TO ANY HAZARDOUS MATERIALS, SOIL COMPACTION, SEWER AYAILABLITY, SEPTIC SYSTEM EVALUATION OR DESIGN, EASEMENT OR TITLE 188UES OR ANY OTHER SITE CONDITIONS AS PART OF ITS SCOPE OF WORK AND PROVIDED SERVICE.
- 8. ALL INSURANCE COYERAGE SHALL BE PROVIDED BY THE GENERAL CONTRACTOR AND SUBCONTRACTORS COYERING WORKMANS COMPENSATION, LIABILITY AND ERRORS OR OMMISSION.
- 9. CONTRACTOR SHALL ENGAGE A STRUCTURAL ENGINEER TO PROVIDE THE SUPPLEMENTAL FOUNDATION AND FRAMING PLANS, DETAILS AND SPECIFICATIONS FOR THIS PROJECT AND SPECIFIC BUILDING SITE CONDITIONS, PLANS SHALL BE SEALED AS
- IO, THESE PLANS ARE NOT INTENDED TO INDICATE THE ENTIRE SCOPE OF WORK FOR THIS PROJECT, BUILDER/CONTRACTOR SHALL ENGAGE THE REQUIRED PROFESSIONALS AND ASSOCIATES AS NEEDED TO PROVIDE ADDITIONAL DRAWINGS, SPECIFICATIONS OR SERVICES NECESSARY TO COMPLETE THIS PROJECT.
- II, READ DIMENSIONS DIRECTLY FROM PLANS, DO NOT TRY TO SCALE PRINTS,

# GENERAL CONSTRUCTION NOTES:

DESIGN CRITERIA/DATA

\* STAIRS DEAD LOAD

\* SOIL BEARING CAPACITY - 2,500 P.S.F. \* FLOOR DEAD LOAD - 10 P.S.F. \* FLOOR LIVE LOAD - 40 P.S.F. \* ROOF LIVE LOAD - 30 P.S.I. \* DECKS LIVE LOAD - 40 P.S.I. \* DECKS DEAD LOAD - 10 P.S.I. \* STAIRS LYE LOAD - 40 P.S.I.

CONCRETE FOUNDATIONS AND SLABS: \* ALL FOOTINGS, FOUNDATIONS, BUILDING SLABS, RETAINING WALLS AND DRIVEWAYS SHALL BEAR ON UNDISTRUBED EARTH OR COMPACTED SOIL MEETING SOIL BEARING MINIMUM OF 2,500 P.S.F. · ALL CONCRETE SHALL COMPY WITH THE ACI SPECIFICATIONS AND SHALL HAVE A MINIMUM COMPRESSIVE STRENGTH OF 3,000 P.S.I. AT 28 DAYS WITH A MAXIMUM SLUMP OF 5". \* ALL BUILDING SLABS SHALL HAVE A REINFORCEMENT OF WWF 6"  $\times$  6" WI.4  $\times$  WI.4 OVER A MOISTURE / YAPOR BARRIER OF 6 MIL POLYETHLENE SHEETING (OR GREATER) LAPPED A MINIMUM OF 12" AND SEALED WITH TAPE OR ADHESIVE, GRAYEL OR CRUSHED STONE MAY BE USED AT CONTRACTOR'S OPTION, SLAB EXPANSION JOINTS SHALL BE INSTALLED/CUT AS REQUIRED. · REINFORCING STEEL AT WALLS, FOOTINGS AND GRADE BEAMS TO BE DEFINED BY ENGINEER,

+ BUILDER SHALL ENGAGE A PROFESSIONAL STRUCTURAL ENGINEER TO PROVIDE SEALED PLANS,

DETAILS AND SPECIFICATIONS RELATING TO ALL CONCRETE WALLS, DECKS AND FOOTINGS.

3. CARPENTRY / FRAMING / SHEATHING / TRUSSES: \* PREVENT MOISTURE AND PHYSICAL DAMAGE TO ALL CARPENTRY AND FRAMING.

- 10 P.S.I.

· PROVIDE WOOD BLOCKING AS REQUIRED TO ANCHOR ANY WALL MOUNTED ACCESSORIES. · SILL6/60LE PLATES ON CONCRETE TO BE 2X PRESURE TREATED MATERIAL ACHORED TO CONCRETE BY SILL PLATE ANCHORS AS DEFINED BY ENGINEER AND APPLICABLE BUILDING CODES. · LOAD BEARING STUDS SHALL BE MINIMUM \*3 STANDARD OR STUD GRADE LUMBER. EXCEPTION: BEARING STUDS NOT SUPPORTING FLOORS AND NONBEARING STUDS SHALL BE PERMITTED TO BE UTILITY GRADE LUMBER, PROVIDED THE STUDS ARE SPACED IN ACCORDANCE WITH

\* FLOOR JOISTS, RAFTERS, HEADERS AND BEAMS TO BE SOUTHERN YELLOW PINE, ENGINEERED LUMBER OR BETTER, CONSULT ENGINEER'S DRAWINGS AND SPECIFICATIONS, ROOF DECKING AND WALL SHEATHING SHALL BE APA RATED/GRADED, ROOFING SHALL BE 1/16" MINIMUM PLYWOOD OR 06B, WALL SHEATHING TO BE MINIMUM 1/16" PLYWOOD OR 06B, \* SUB FLOORING SHALL BE APA STURD-I-FLOOR, EXPOSURE I, SPAN RATING IN ACCORDANCE WITH APA RECOMMENDATIONS FOR SUPPORT SPACING 3/4" THICKNESS. · WOOD TRUSSES SHALL BE DESIGNED IN ACCORDANCE WITH ANSI/TPI 1, "NATIONAL DESIGN

STANDARD FOR METAL PLATE CONNECTED WOOD TRUSS CONSTRUCTION", TRUSS VENDOR SHALL SUPPLY DRAWINGS WITH AN ENGINEER'S SEAL, SEPERTE FROM, AND AS A SUPPLEMENT TO, THIS SET OF DRAWINGS.

BUILDER SHALL ENGAGE A PROFESSIONAL STRUCTURAL ENGINEER TO PROVIDE SEALED PLANS, DETAILS AND SPECIFICATIONS RELATING TO ALL STRUCTURAL WOOD FRAMING FOR FLOORS, WALLS, DECKS, BEAMS AND RAFTERS,

## FLOOR SYSTEM NOTES:

MANUFACTURED FLOORTRUGG SYSTEMS, ENGINEERED LUMBER AND WOOD BEAMS TO BE USED, tHE MANUFACTURED FLOOR SYSTEM SUPPLIER WILL PROVIDE ENGINEERED LAYOUT DRAWINGS FOR CONSTRUCTION PURPOSES FOR THE ITEMS MENTIONED ABOVE. ANY SPECIAL REQUIREMENTS OF THE FLOOR, CEILING AND ROOF SYSTEMS, ALONG WITH HEADER AND BEAM REQUIREMENTS SHOULD BE CONSIDERED AND SHOWN ON THOSE LAYOUT DRAWINGS, tHE DESIGNER ASSUMES NO LIABILITY FOR THE DESIGN OR PERFORMANCE OF THE FLOOR SYSTEMS, CEILING SYSTEMS, ROOF SYSTEMS, BEAMS OR HEADERS.

# GENERAL CONSTRUCTION NOTES CONTINUED:

4. MOISTURE PROTECTION: \* APPLY MOISTURE BARRIER PER CODE OVER WALL SHEATHING. PER MANUFACTURE'S APPLICATION SPECIFICATIONS.

5. BRICK OR STONE MASONRY:

\* ALL MASONRY TO HAVE NON-CORROSIVE METAL TIES AT 16" O.C. VERTICALLY AND HORIZONTALLY. AND WEEP HOLES 24" O.C. AT BASE FLASHING, A 1" MINIMUM AIR SPACE SHALL BE MAINTAINED BETWEEN THE MASONRY AND WALL SHEATHING, INSTALL THROUGH-WALL FLASHING AS REQUIRED. \* MORTAR TO CONFORM TO ASTM C2TO, TYPE N.

6. VENTILATION: \* YENTILATION OF ATTIC SPACE SHALL BE PROVIDED TO FURNISH CROSS YENTILATION WITH WEATHER PROTECTED SCREENED YENTS IN ACCORDANCE WITH THE 2018 IRC, LATEST EDITION AND ALL STATE AND LOCAL CODES UNLESS SPRAY FOAM INSULATION IS USED.

7. WINDOWS AND DOORS:

\* ALL WINDOW, DOORS AND CASED OPENINGS ARE SHOWN AS FINISHED OPENING SIZE ONLY. CONSULT SPECIFIC WINDOW AND DOOR MANUFACTURES FOR EXACT WINDOW AND ROUGH OPENING SIZES.

\* ALL WINDOWS SHALL HAVE INSULATING GLASS CONSTRUCTION. \* EVERY SLEEPING ROOM SHALL HAVE AT LEAST ONE OPERABLE WINDOW OR EXTERIOR DOOR APPROVED FOR EMERGENCY EGRESS OR RESCUE AND MUST MEET OR EXCEED THE

MINIMUM CODE REQUIREMENTS (IRC SECTIONS R310.1 - R310.1.4, R310.5) · WHERE WINDOWS ARE PROVIDED AS A MEANS OF EGRESS OR RESCUE THEY SHALL HAYE A SILL HEIGHT OF NOT MORE THAN 44 INCHES ABOYE THE FLOOR. · ALL EGRESS OR RESCUE WINDOWS FROM SLEEPING ROOMS MUST HAVE A MINIMUM NET CLEAR OPENING OF 5.7 SQUARE FEET. THE MINIMUM NET CLEAR OPENING WIDTH SHALL BE 20 INCHES.

REVIEW ALL WINDOW SIZES WITH WINDOW MANUFACTURE TO ASSURE EGRESS REQUIREMENTS, \* TEMPERED GLAGG SHALL BE INSTALLED IN WINDOW AND DOOR LOCATIONS AS REQUIRED. · ALL WINDOWS SHALL BE FLASHED AND INSTALLED IN COMPLIANCE WITH MANUFACTURE'S INSTALLATION INSTRUCTIONS.

8. FIREPLACES AND CHIMNEYS:

· ALL MASONRY VENEER AT INTERIOR FIREPLACE LOCATIONS SHALL BE STRUCTURALLY SUPPORTED AS REQUIRED, CONSULT ENGINEER'S DETAILS AND DRAWINGS, · INSTALL PREFAB UNITS OR "ISOKERN" STYLE FIREBOX UNITS PER MANUFACTURER'S SPECIFICATIONS AND ALL APPLICABLE CODES.

· IF ISOKERN OR MASONRY TYPE FIREBOXES ARE CONSTRUCTED, ENGINEER SHALL DESIGN SUPPORT SPECIFICATIONS AND DETAILS. + CHIMNEYS SHALL EXTEND AT LEAST 2'-O" HIGHER THAN ANY PORTION OF THE BUILDING WITHIN 10'-0" AND SHALL NOT BE LESS THAN 3'-0" ABOYE THE POINT THE CHIMNEY PASSES THROUGH

THE ROOF UNLESS FIREPLACE IS CLASSIFIED AS AN APPLIANCE. \* SUPPORT MASONRY VENEER AT EXTERIOR CHIMNEY LOCATIONS ABOVE ROOF PLANE AS REQUIRED, CONSULT ENGINEER'S PLANS AND DETAILS.

\* ASPHALT SHINGLE ROOFING SHALL BE INSTALLED PER MANUFACTURE'S GUIDELINES OVER MINIMUM 15LB, BUILDING FELT WITH AT LEAST A 4/12 PITCH,

SHINGLE WEIGHT SHALL COMPLY WITH DEVELOPMENT ARCHITECTURAL REQUIREMENTS. · METAL ROOFING SHALL BE EITHER COPPER OR PREFINISHED KYNAR STANDING SEAM AS PER THE DRAWINGS AND SHALL BE INSTALLED PER MANUFACTURE'S GUIDELINES WITH NON-CORROSIVE AND APPRORIATE LENGTH FASTENERS.

10. HYAC, PLUMBING AND ELECTRICAL:

· ALL WORK SPERFORMED AND MATERIALS PROVIDED SHALL BE IN ACCORDANCE WITH THE SPECIFIC AND APPLICABLE CODE REFERENCES ABOYE UNDER "APPLICABLE BUILDING CODES". ALL ROOF PENETRATIONS (VENTS) SHALL BE LOCATED AT THE REAR ROOF PLANE OF THE BUILDING AND SHALL BE PAINTED TO MATCH ROOFING COLOR.

#### PROJECT PERSONNEL INFORMATION:

CONTRACTOR/BUILDER:

DESIGNER:

5315 PIEDMONT MOUNTAIN ROAD PROJECT ADDRESS: CLARKESYILLE, GA 30523

MICHAEL SWILLEY DESIGN P.O. BOX 1223 TRENTON, GA 30752

TO BE DETERMINED

770-656-3031

LAND PLANNER TO BE DETERMINED

ENGINEER: TO BE DETERMINED

#### APPLICABLE BUILDING CODES:

THE GEORGIA STATE MINIMUM STANDARD CODES:

HABERSHAM COUNTY CONSTRUCTION CODE

AND IPC APPENDIX F.

INTERNATIONAL MECHANICAL CODE

2018 EDITION WITH 2020 GEORGIA STATE AMENDMENTS INTERNATIONAL PLUMBING CODE 2018 EDITION WITH 2020 GEORGIA STATE AMENDMENTS

INTERNATIONAL FUEL GAS CODE 2018 EDITION WITH 2020 GEORGIA STATE AMENDMENTS

NFPA NATIONAL ELECTRICAL CODE 2017 EDITION INTERNATIONAL ENERGY CONSERVATION CODE

2015 EDITION WITH 2020 GEORGIA STATE SUPPLEMENTS AND AMENDMENTS INTERNATION RESIDENTIAL CODE FOR ONE AND TWO FAMILY DWELLINGS, 2018 EDITION WITH 2020 GEORGIA STATE AMENDMENTS

#### SQUARE FOOTAGE SUMMARY:

BASEMENT 1,054 S.F. MAIN FLOOR 1.054 S.F. TOTAL CONDITIONED/FINISHED 2,108 S.F. FRONT AND REAR PORCHES 450 S.F.

288 S.F.

NOTE: ALL SQUARE FOOTAGES ARE CALCULATED TO THE OUTSIDE FACE OF STUD.

### INDEX OF DRAWINGS:

STORM ROOM

NOTES, COVER PAGE ..FRONT AND LEFT ELEVATIONS 2 OF 5... 3 OF 5.... ... RIGHT AND REAR ELEVATIONS ...BASEMENT AND FIRST 4 OF 5 5 OF 5... ..ROOF PLAN

S  $\forall$ 

GENERAL NOTES:


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REVISIONS:

SHEET NO.

PROJECT NO .:



SEE GENERAL NOTES, CONDITIONS AND REQUIREMENTS ON PAGE I PRIOR TO ANY CONSTRUCTION,

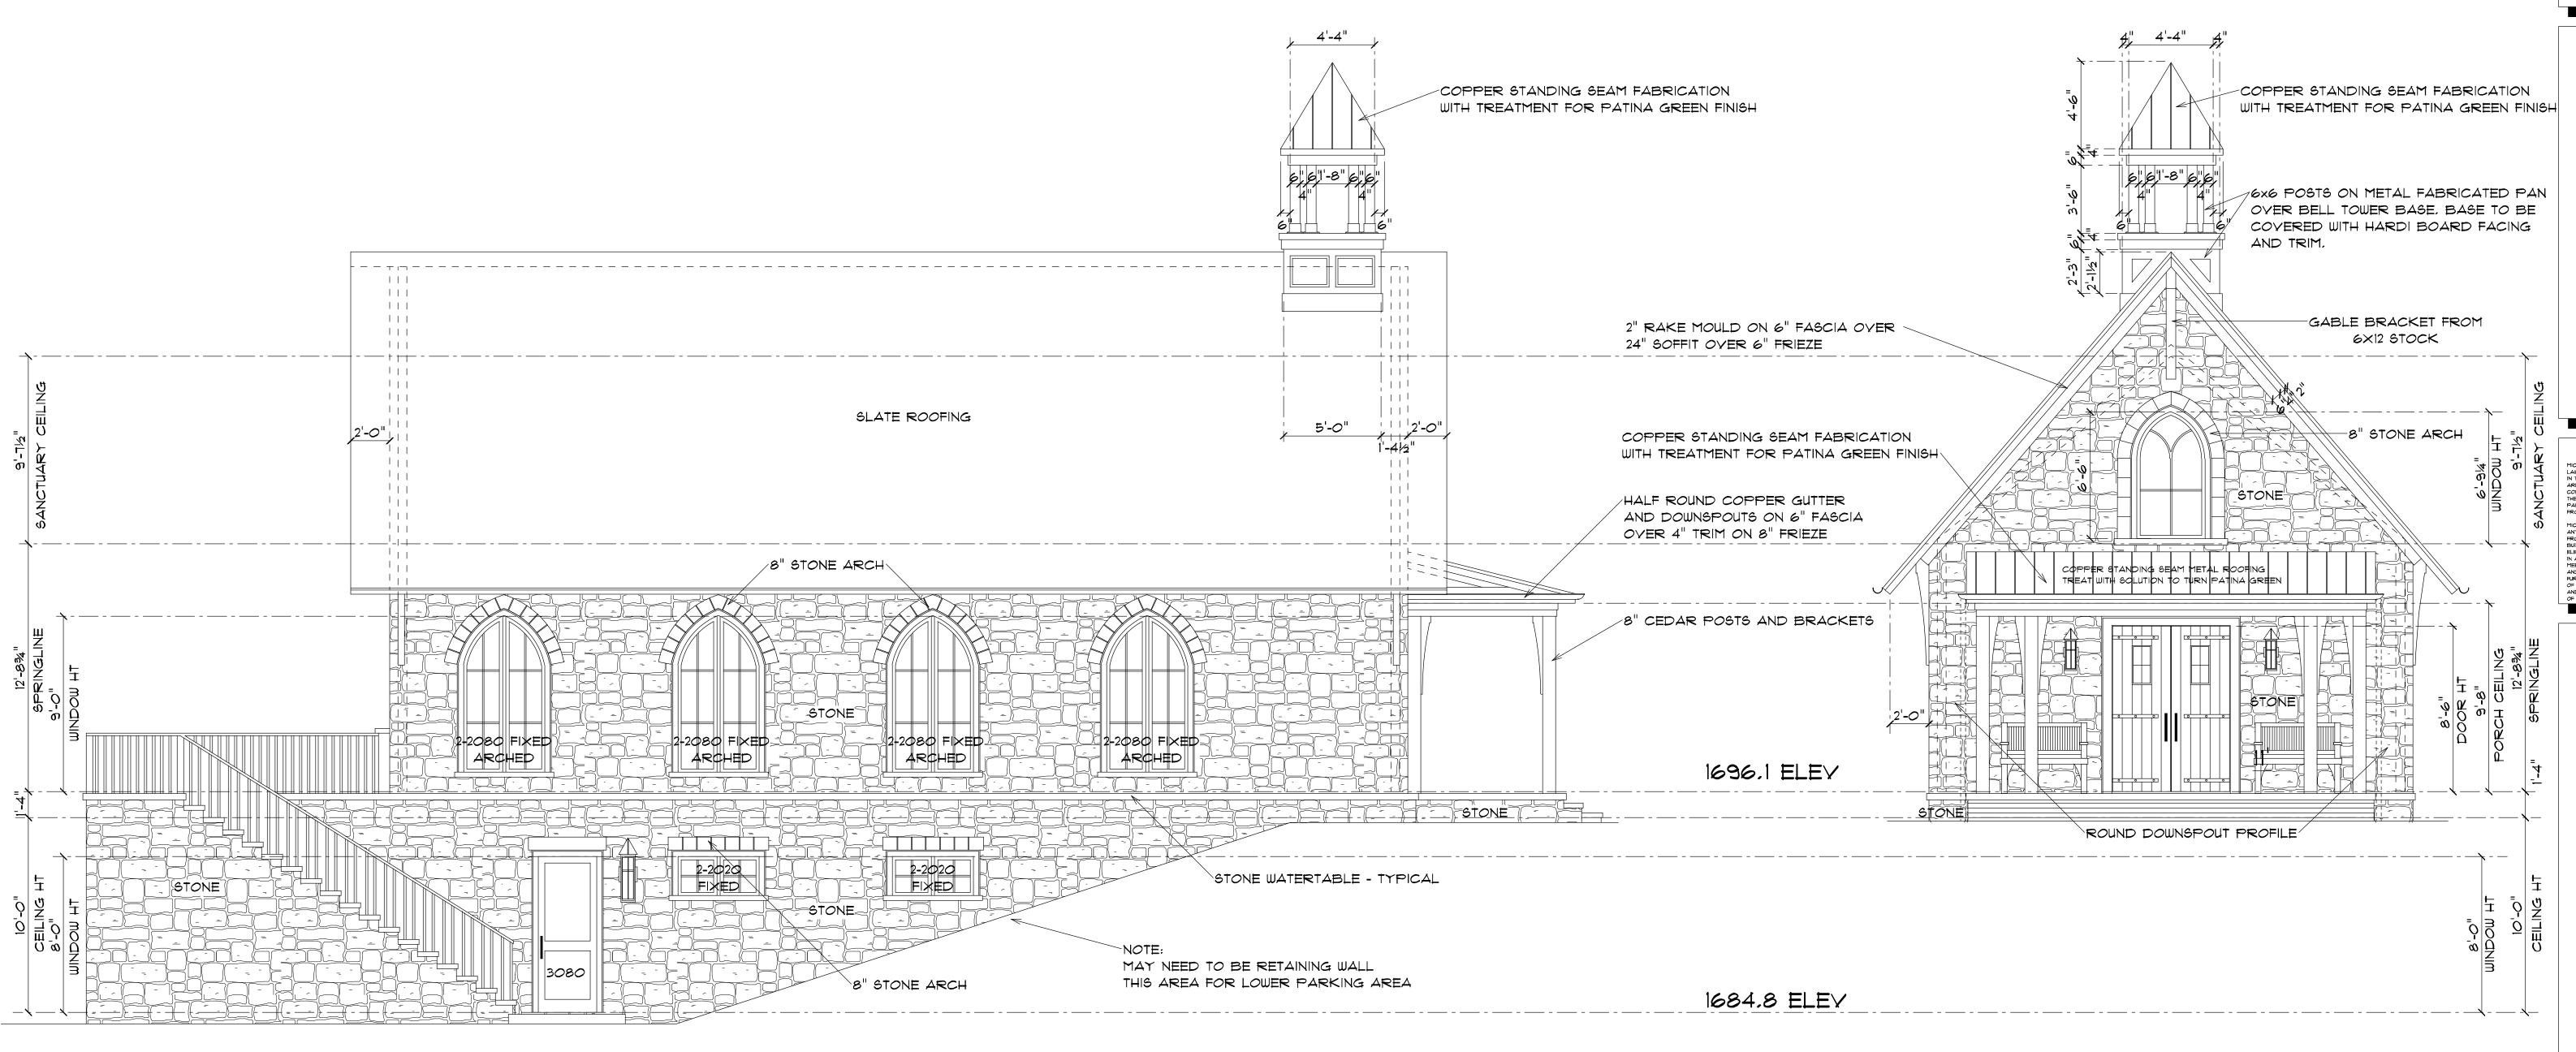LEFT ELEVATION 1/4" = 1'-0"

FRONT ELEVATION 1/4" = 1'-0"

# ELEVATION NOTES

- ALL EXTERIOR WINDOWS AND DOORS TO HAVE IX4 W/BACKBAND SURROUND UNLESS NOTED.
- ALL WINDOWS SHOWN AS FIXED WINDOWS.

GENERAL NOTES: MICHAEL SWILLEY DESIGN RESERVES ITS COMMON LAW COPYRIGHT AND OTHER PROPERTY RIGHTS IN THESE PLANS. THESE IDEAS, DESIGNS AND PLANS ARE NOT TO BE REPRODUCED, CHANGED OR COPIED IN ANY FORM OR MANNER. IN ADDITION, THEY ARE NOT TO BE ASSIGNED TO ANY THIRD PARTY WITHOUT OBTAINING WRITTEN PERMISSION FROM MICHAEL SWILLEY DESIGN. MICHAEL SUILLEY DESIGN DOES NOT ASSUME
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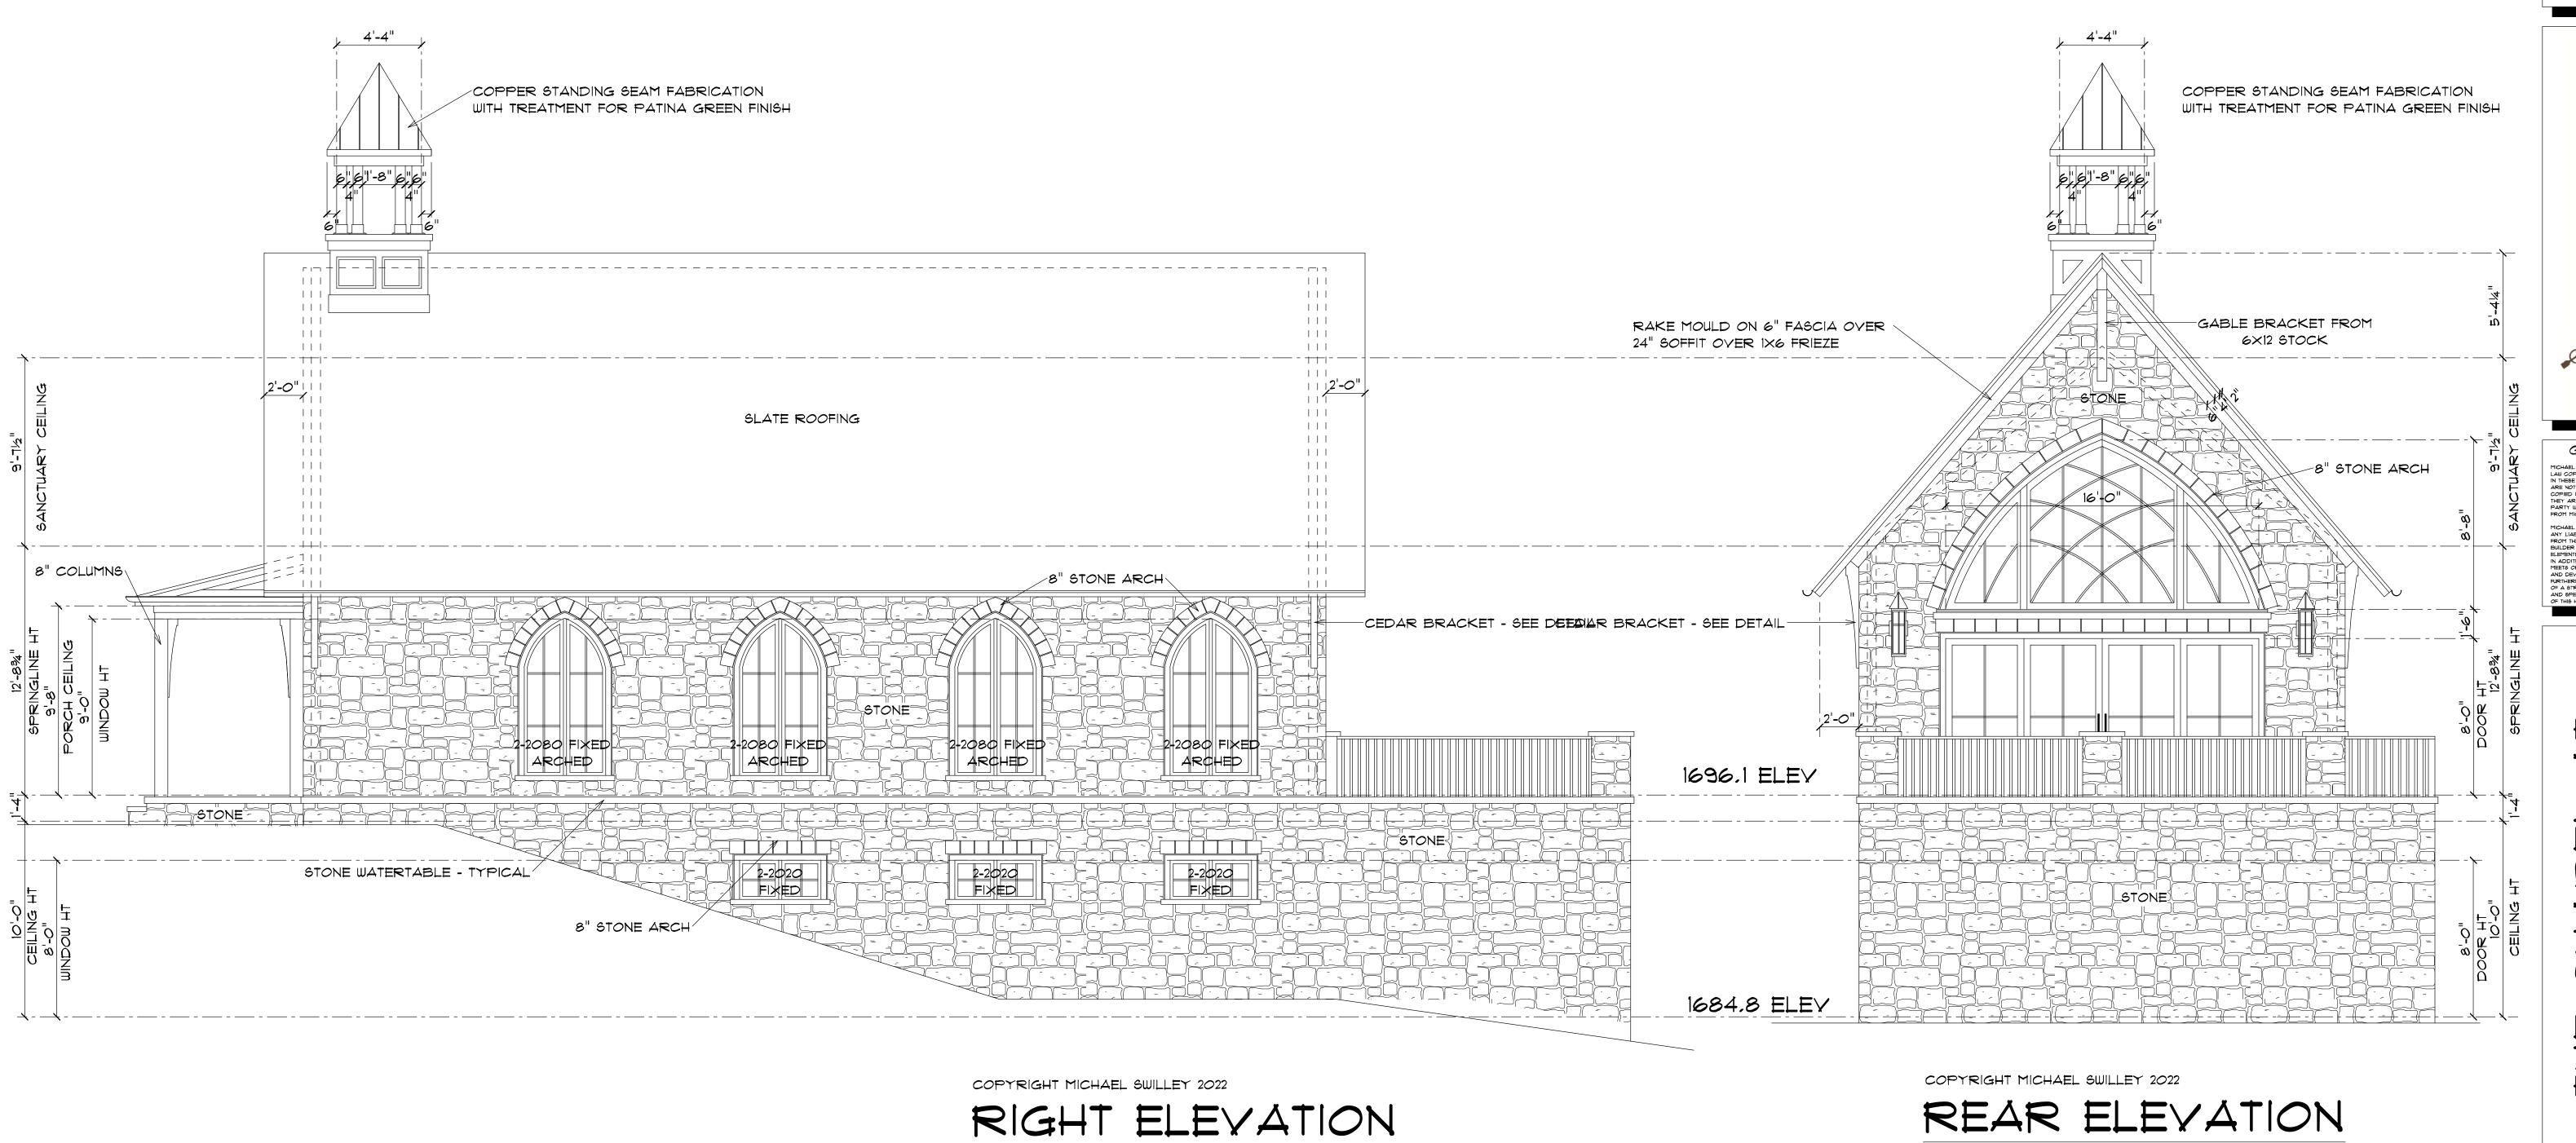
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1/4 = 1'-0"

# REAR ELEVATION

1/14" = 1'-0"

# ELEVATION NOTES

- ALL EXTERIOR WINDOWS AND DOORS TO HAVE IX4 W/BACKBAND SURROUND UNLESS NOTED.
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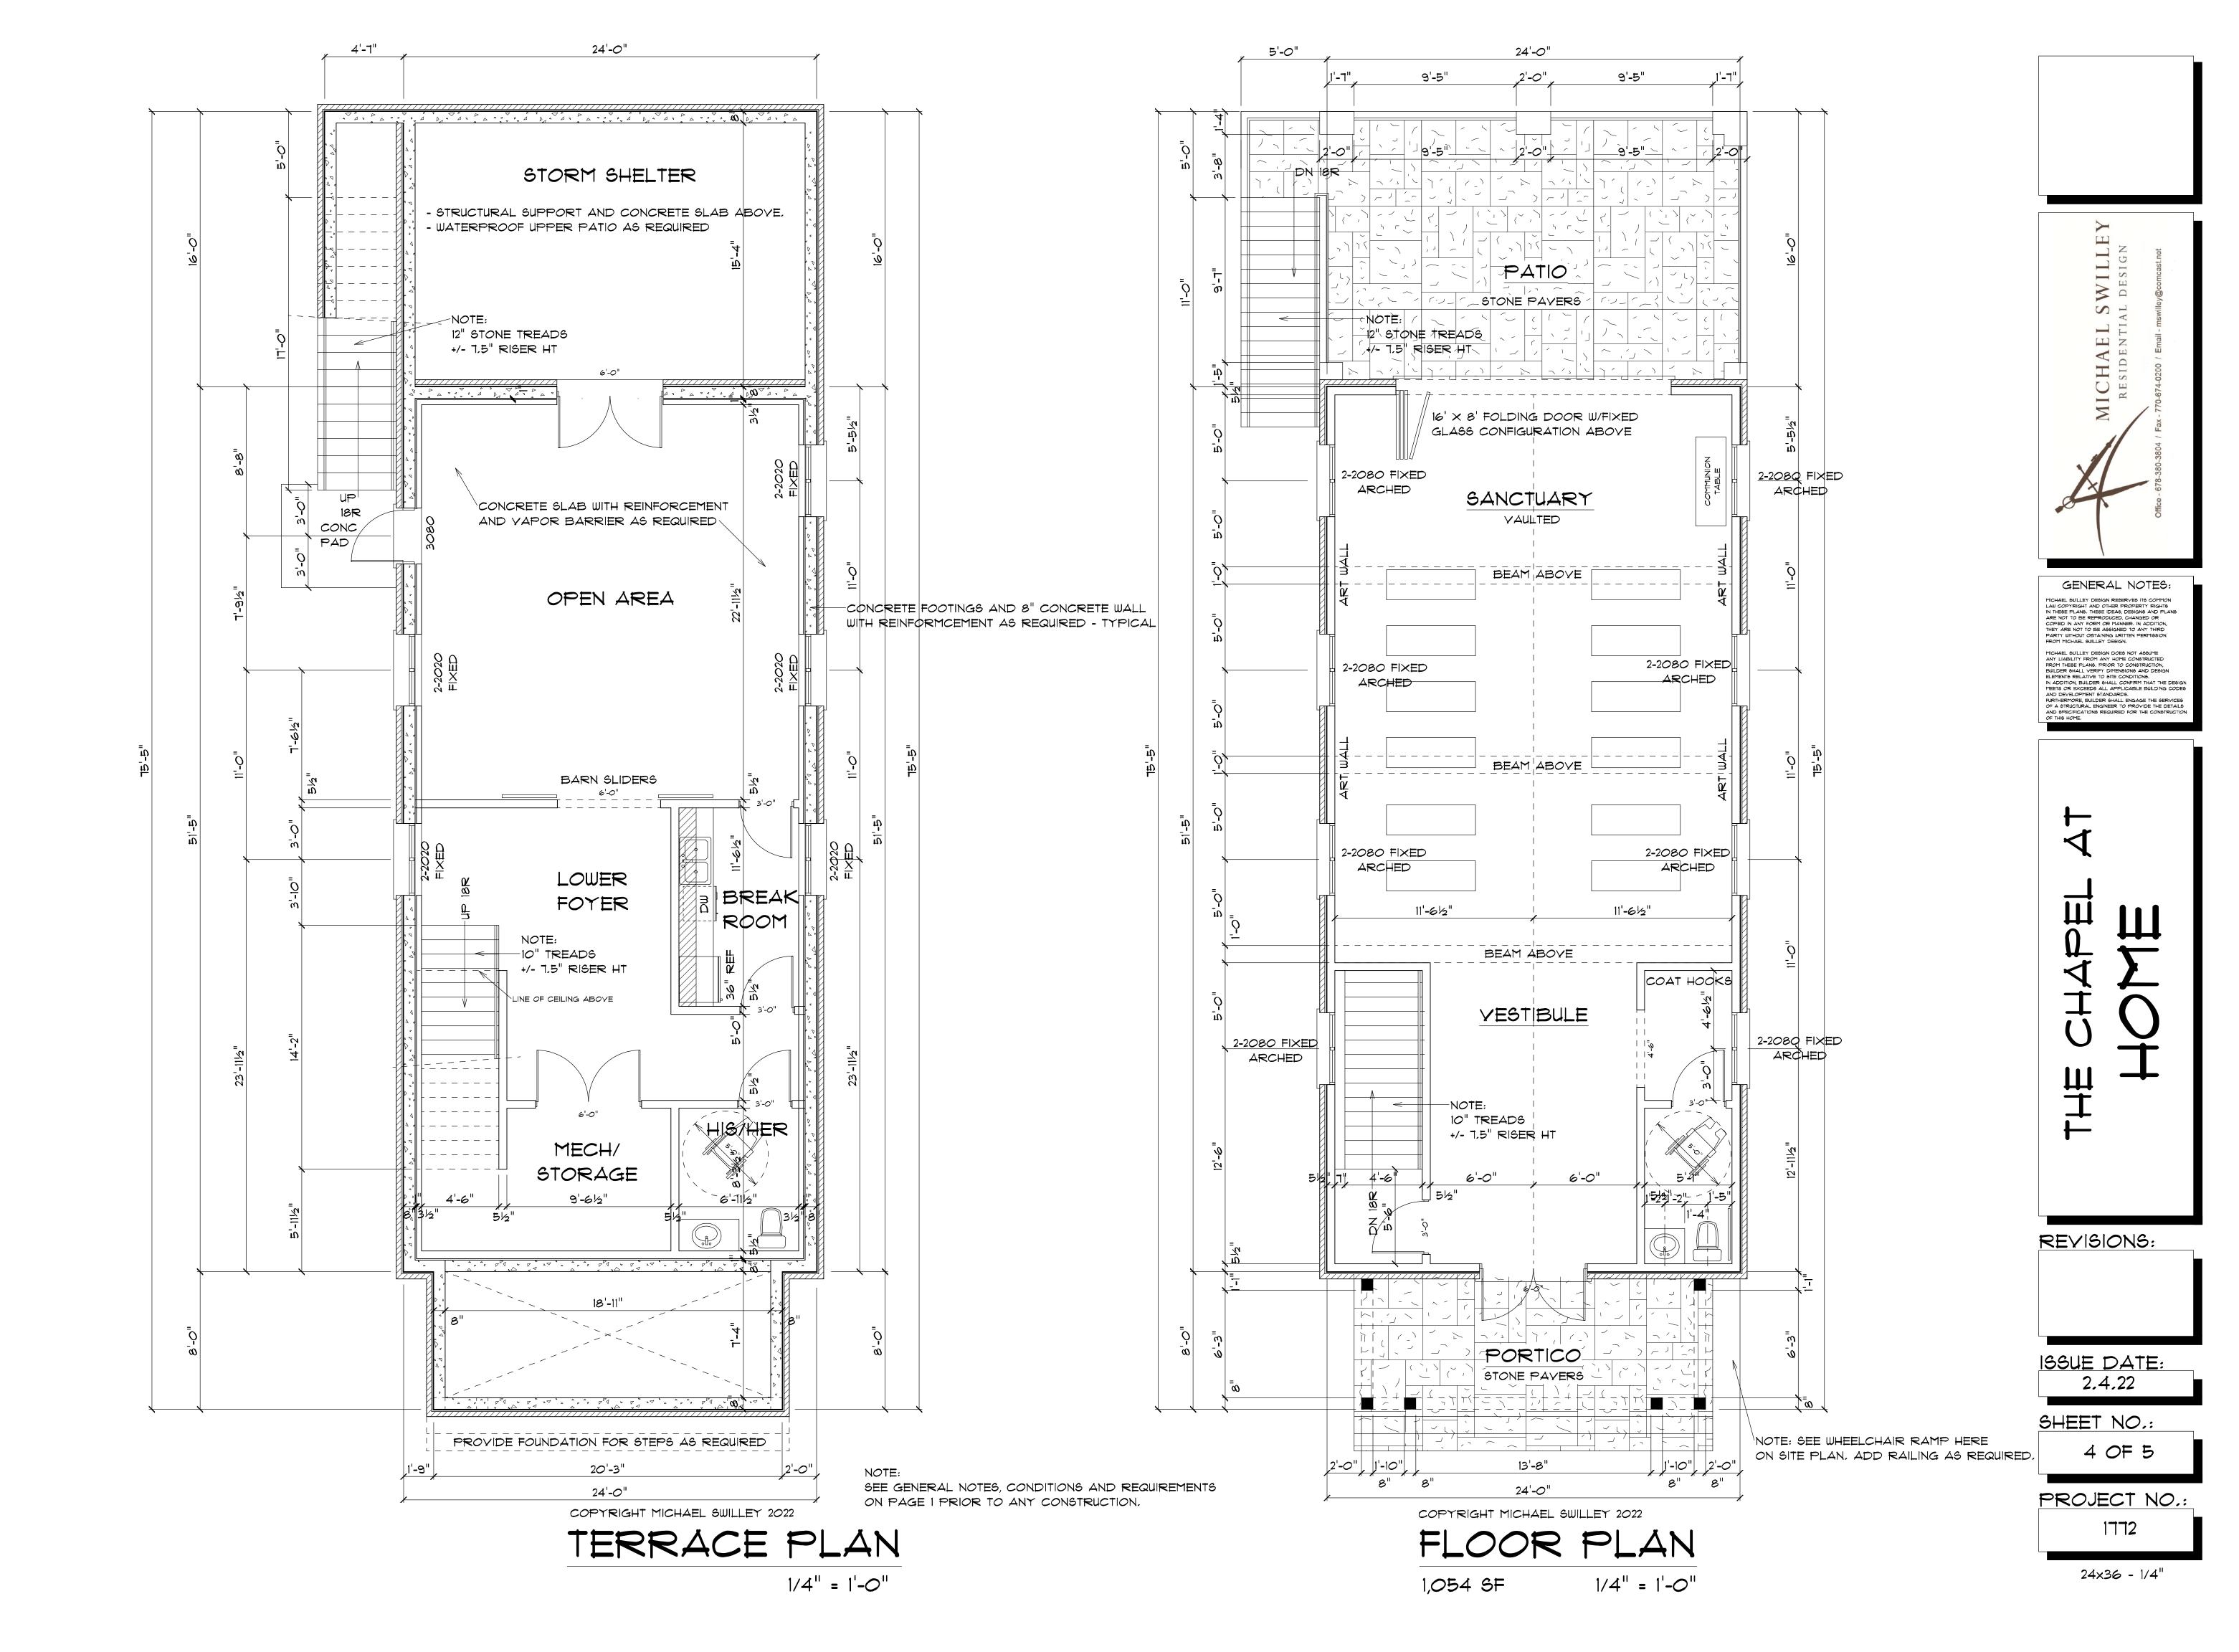
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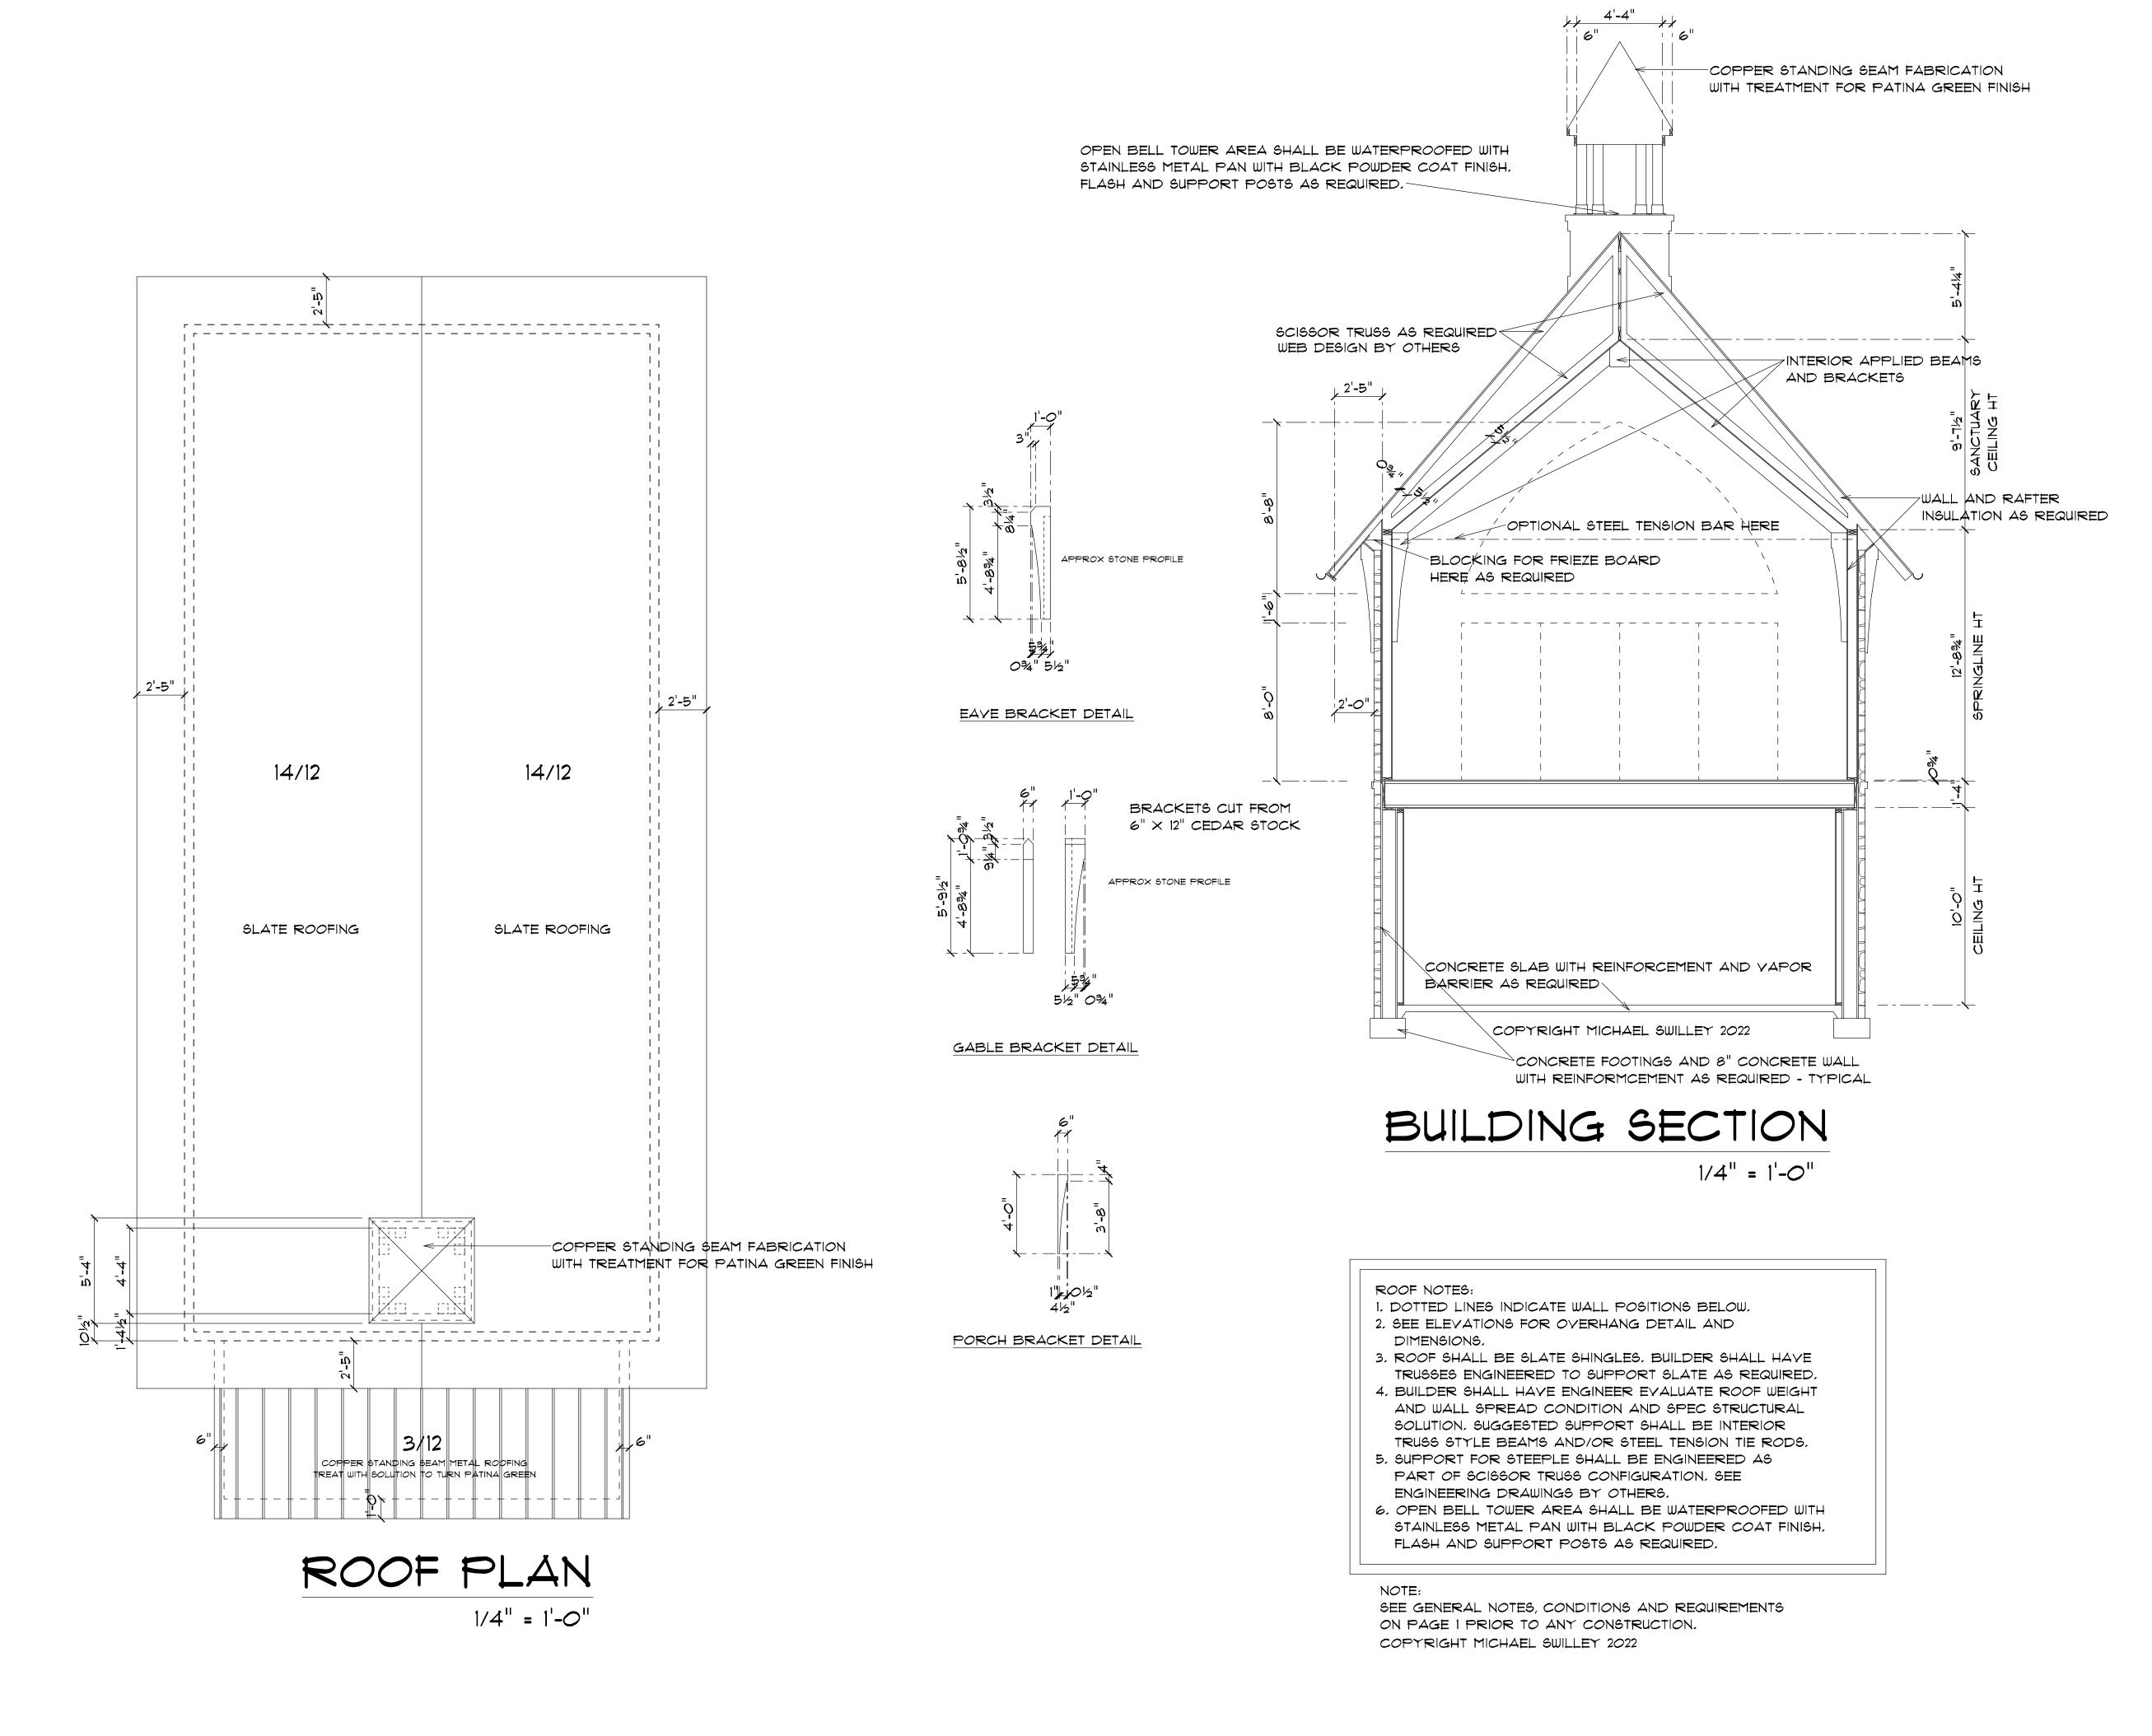
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PROJECT NO .: 1772

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SHEET NO .:

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PROJECT NO.